



PLAN
Scale 1:50
PARALLEL IN / OUT PIPE OPTION

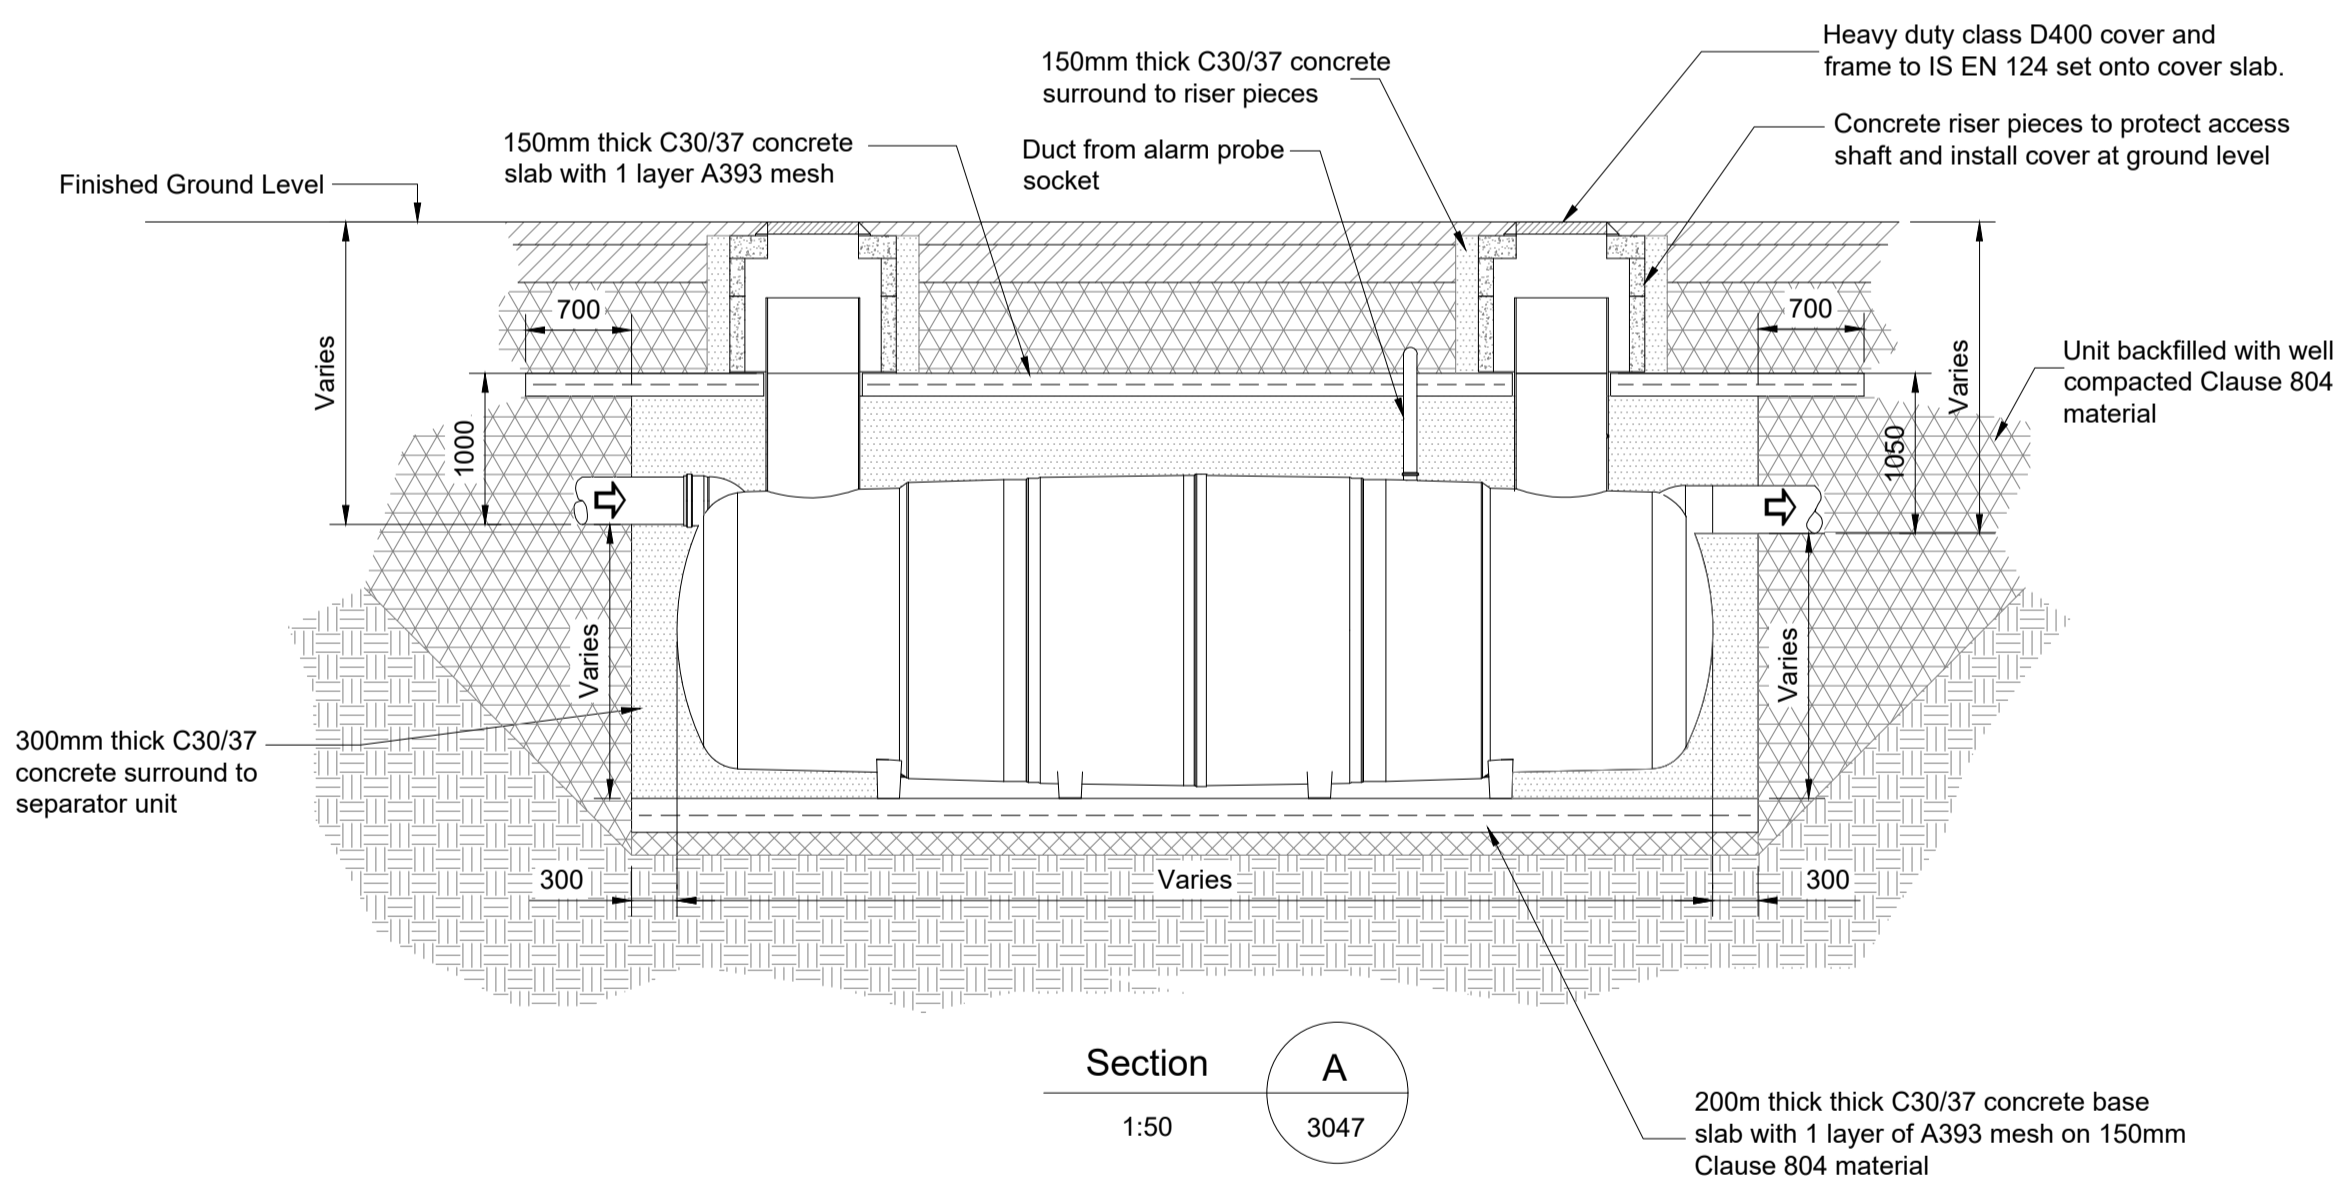


Section A
1:50
3047

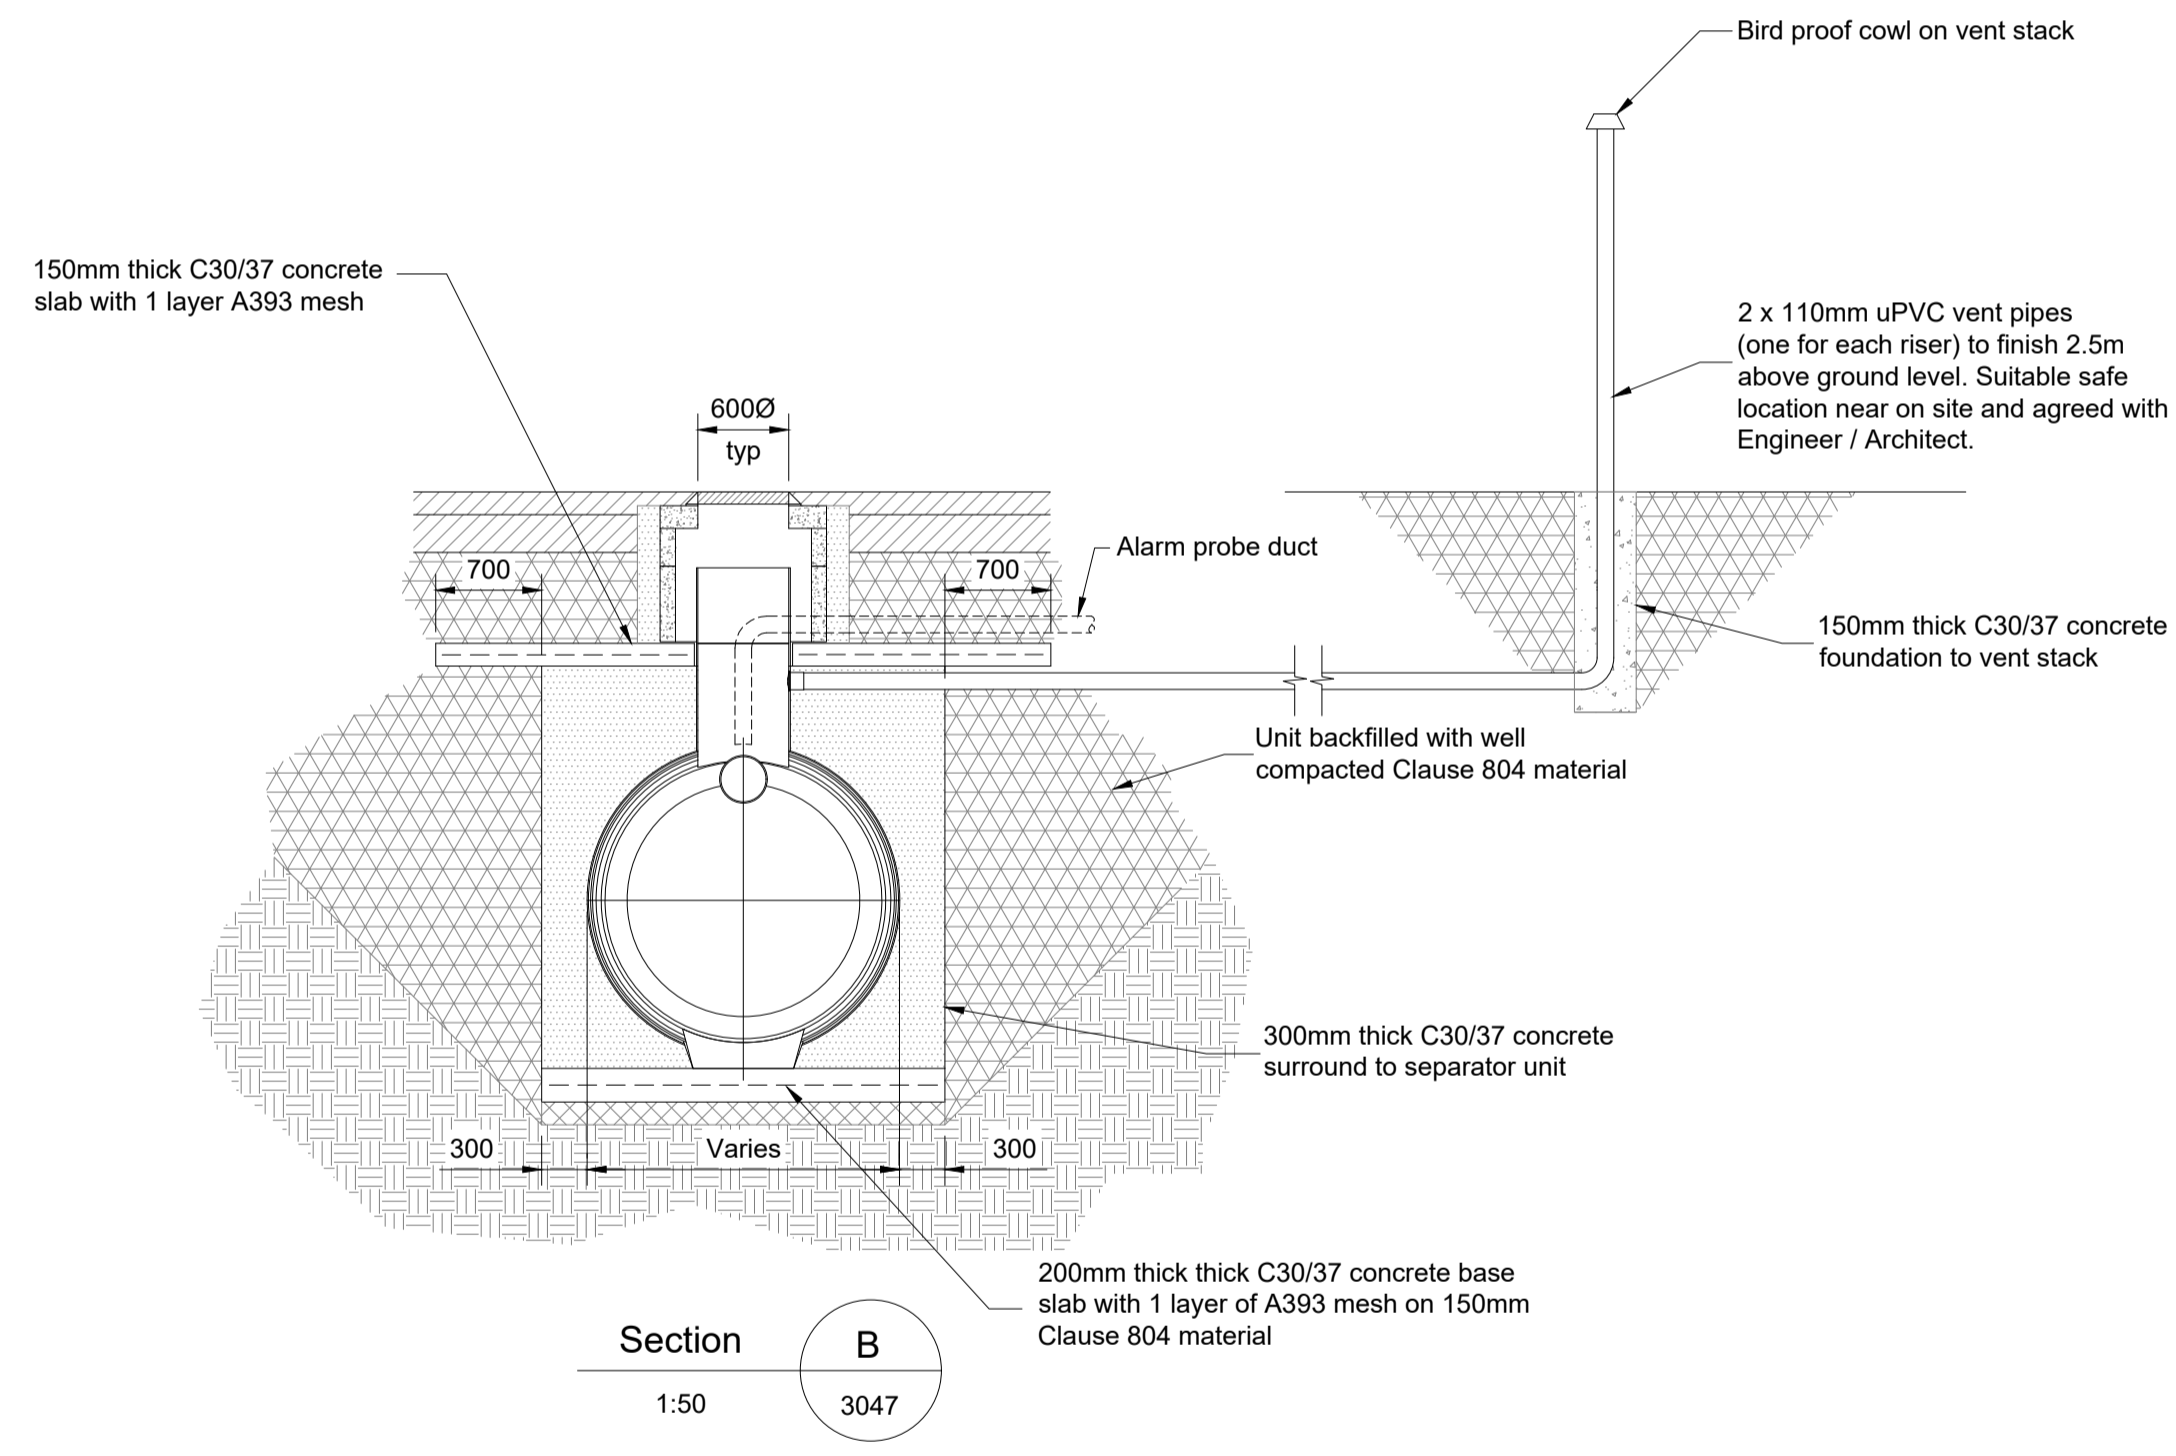

Section B
1:50
3047

- Notes
1. Design suitable for planning purposes only. Not suitable for construction.
 2. This drawing to be read in conjunction with all other drawings and specifications.
 3. Do not scale off this drawing. Use figured dimensions only.

Key to symbols

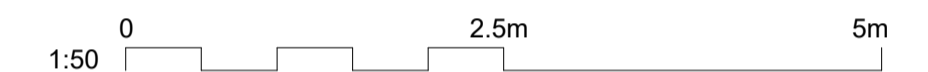

Reference drawings

- 229100428-MMD-00-XX-DR-E-3040 - Overview of Water and Drainage Proposals
- 229100428-MMD-00-XX-DR-E-3041 - Proposed Storm Water Drainage Layout Sheet 1 of 2
- 229100428-MMD-00-XX-DR-E-3042 - Proposed Storm Water Drainage Layout Sheet 2 of 2
- 229100428-MMD-00-XX-DR-E-3043 - Proposed Foul Drainage Layout
- 229100428-MMD-00-XX-DR-E-3044 - Proposed Watermain Layout - Sheet 1 of 2
- 229100428-MMD-00-XX-DR-E-3045 - Proposed Watermain Layout - Sheet 2 of 2
- 229100428-MMD-00-XX-DR-E-3046 - Typical Drainage Details Sheet 1 of 6 - Stormwater Manholes and Gullies
- 229100428-MMD-00-XX-DR-E-3048 - Typical Drainage Details Sheet 3 of 6 - Flow Control Chamber
- 229100428-MMD-00-XX-DR-E-3049 - Typical Drainage Details Sheet 4 of 6 - Attenuation Storage Tank
- 229100428-MMD-00-XX-DR-E-3050 - Typical Drainage Details Sheet 5 of 6 - Compensation Storage Tank
- 229100428-MMD-00-XX-DR-E-3051 - Typical Drainage Details Sheet 6 of 6 - Emergency Shut-Off Valve Chamber

PL1	25/06/2021	SHY	Issued for Planning	DH	TK
Rev	Date	Drawn	Description	Ch'k'd	App'd

MOTT MACDONALD

South Block
Rockfield
Dundrum
Dublin 16
Ireland
T +353 (0)1 291 6700
F
W www.mottmac.com



Title
Celtic Interconnector
Converter Station Site (at Ballyadam)
Typical Drainage Details - Sheet 2 of 6
Oil / Fuel Interceptor

Designed	D.Murphy	Eng check	D.Murphy
Drawn	E.Richardson	Coordination	D.Monaghan
Dwg check	D.Murphy	Approved	T. Keane
Scale at A1	Status	Rev	Security
1:50	APR	PL1	STD

Drawing Number
229100428-MMD-00-XX-DR-E-3047